

1. "SUBDIVISION PLAN, TAX LOT F/3 FOR H. JAMES KENNEDY, 539 ISAAC FRYE HIGHWAY, WILTON, NH HILLSBOROUGH COUNTY, SCALE: 1"=60', DATED DECEMBER 2015, PREPARED BY ARTHUR F. SICILIANO JR, LAND SURVEYOR" AND RECORDED IN THE HILLSBOROUGH COUNTY REGISTRY OF DEEDS AT PLAN NUMBER 3882. TOPOGRAPHICAL VERSION OF PLAN IS UNRECORDED AND ON FILE AT THE TOWN OF WILTON. 2. "PROPOSED SEWAGE DISPOSAL SYSTEM PLAN, TAX MAP F LOT 3-2, WILTON, NH, ISAAC FRYE HIGHWAY, PREPARED FOR

SAN KEN HOMES, INC., PREPARED BY FIELDSTONE LAND CONSULTANTS, DATED FEBRUARY 22, 2021. UNRECORDED.

1. OWNER OF RECORD: ISAAC FRYE HOLDINGS, LLC, 586 TURNPIKE ROAD, NEW IPSWICH, NH 03071 2. THE EXISTING TOPOGRAPHY SHOWN HEREON WAS PROVIDED BY FIELDSTONE LAND CONSULTANTS AND THIS PLAN SHEET IS TO ONLY SHOW THE CURRENT EXISTING CONDITIONS. 3. THE CURRENT ZONING FOR SUBJECT PROPERTY AND ABUTTING PROPERTIES IS GENERAL RESIDENCE AND AGRICULTURAL DISTRICT (RA ZONE).





CONTACT DIG SAFE 72 HOURS PRIOR TO CONSTRUCTION

THE LOCATION OF ANY UTILITY INFORMATION SHOWN ON THIS PLAN IS APPROXIMATE. THE ENGINEERS MAKE NO CLAIM TO THE ACCURACY OR COMPLETENESS OF UTILITIES SHOWN. THE CONTRACTOR IS RESPONSIBLE FOR VERIFYING ANY UTILITIES WHETHER THEY BE ABOVE OR BELOW GROUND. PRIOR TO ANY EXCAVATION ON SITE THE CONTRACTOR SHALL CONTACT DIG SAFE AT 1-800-DIG-SAFE.

SYMBOLS LEGEND

 $-\phi$ OHW - UTILITY POLE AND OVERHEAD WIRES \sim EXISTING AND PROPOSED TREELINE EXISTING 2 FT CONTOUR INTERVAL BUILDING SETBACK LINE _F625± EXISTING SPOT GRADE EXISTING OR PROPOSED DRAINAGE FLOW WELL W EXISTING OR PROPOSED WELL

OWNER SIGNATURE ISAAC FRYE HOLDINGS, LLC

DATE


APPROVED BY THE WILTON NH PLANNING BOARD


CHAIRPERSON / VICE CHAIRPERSON

DATE


Rokeh Consulting, LLC 89 KING ROAD, CHICHESTER, NH PH: 603-387-8688

SCALE: 1"=60' DATE: NOVEMBER 15, 2021 DR. BY: JR CK. BY: JR JOB NO. _____ SHEET NO. 1 OF 4

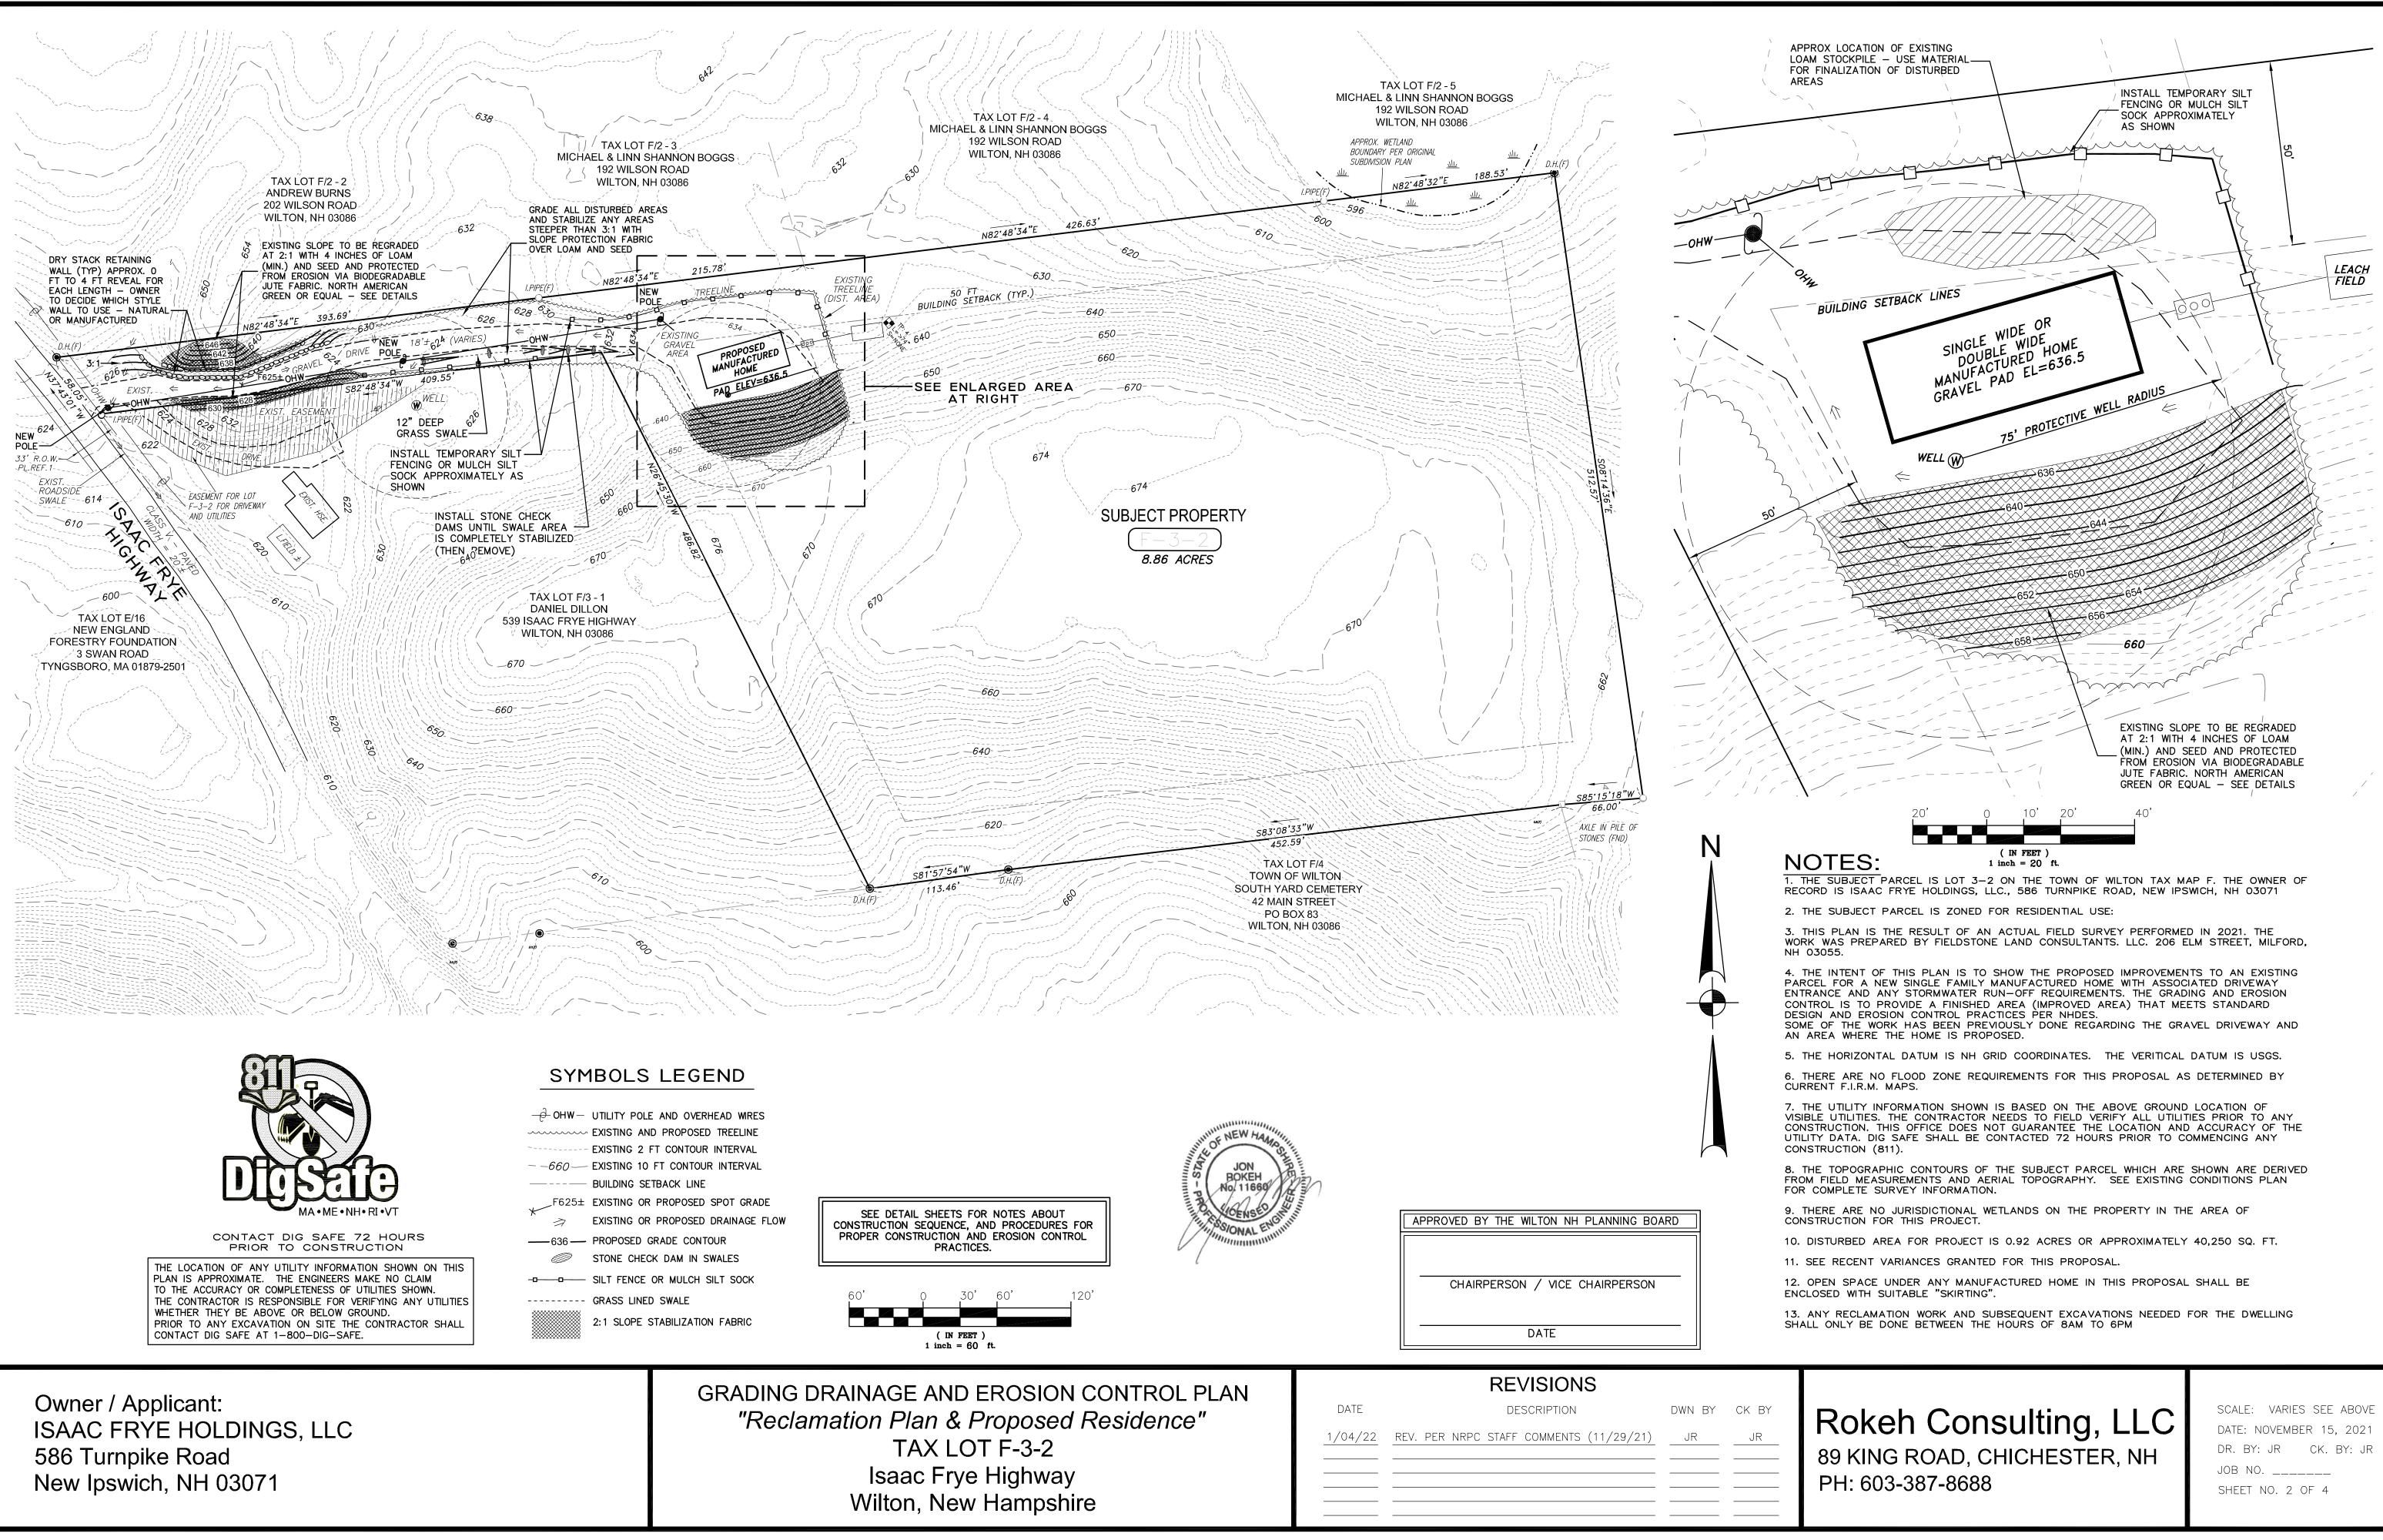

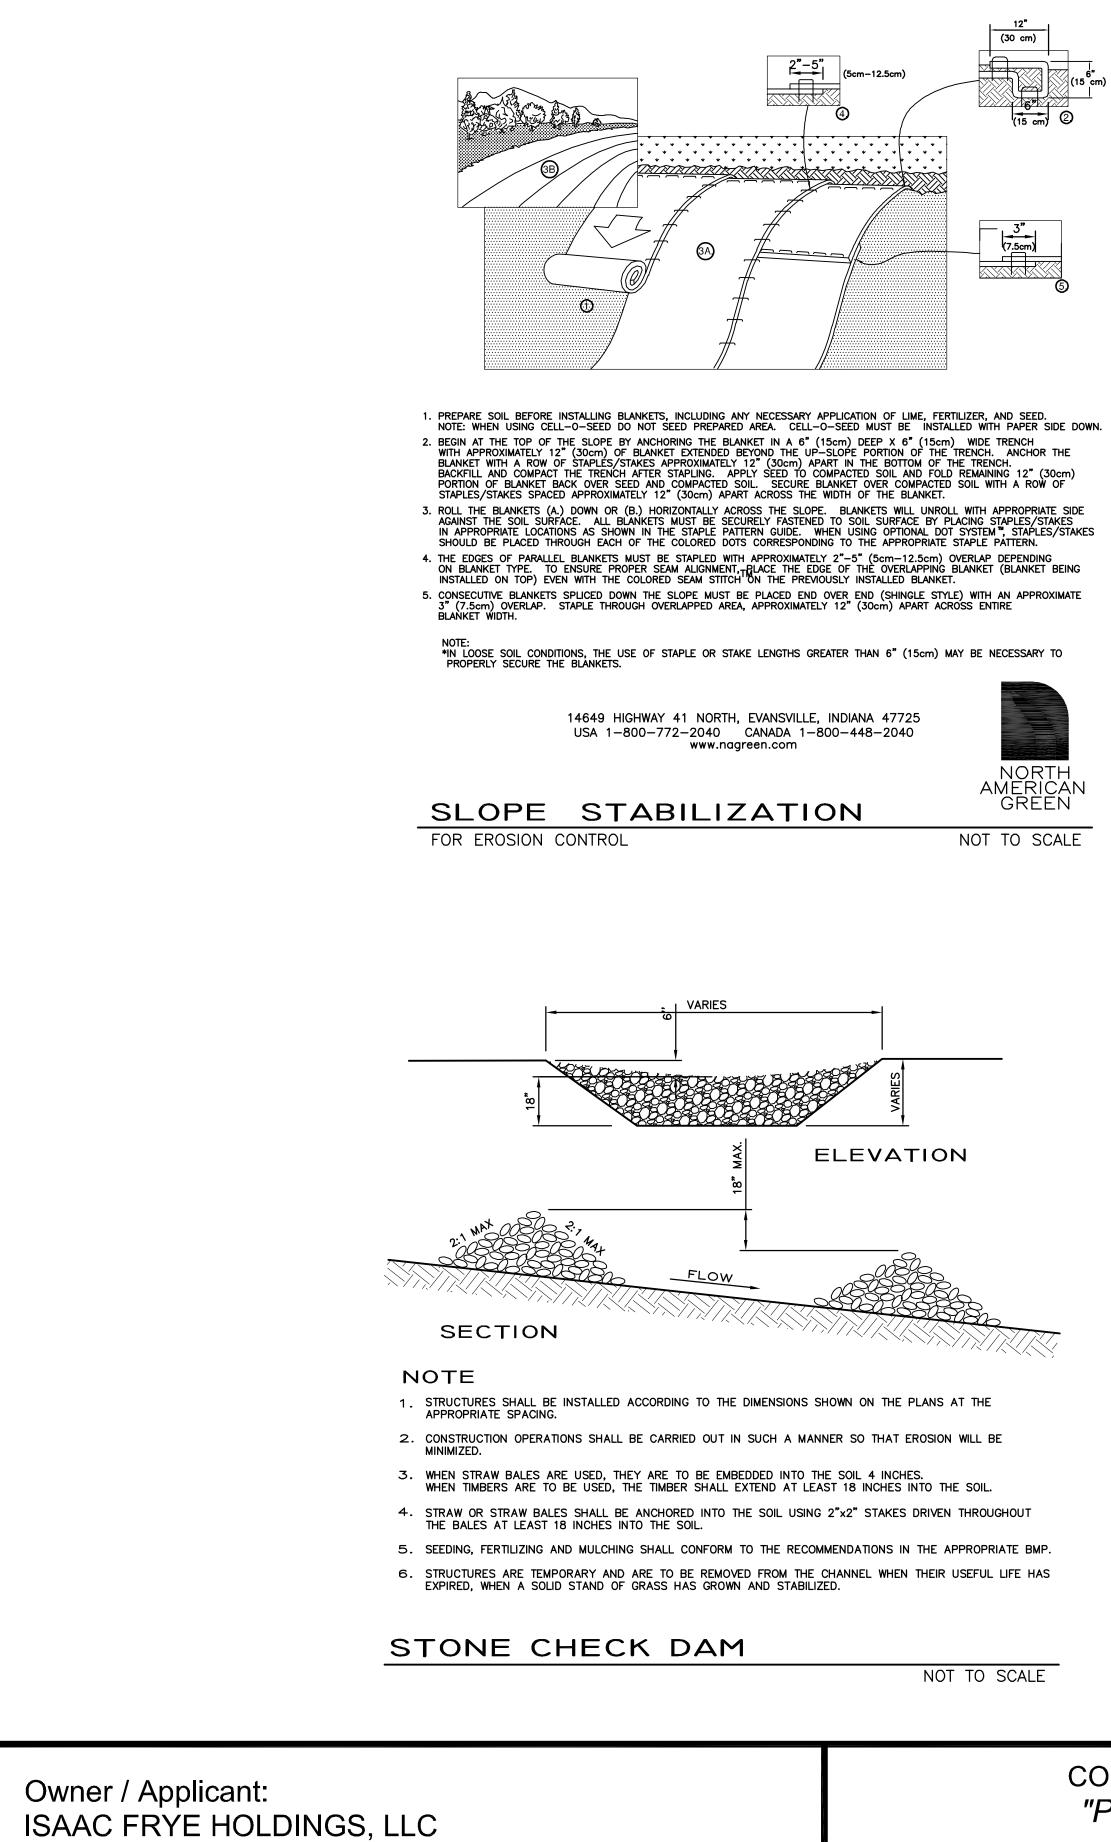


586 Turnpike Road New Ipswich, NH 03071 CONSTRUCTION DETAILS "Proposed Residence" TAX LOT F-3-2 Isaac Frye Highway Wilton, New Hampshire

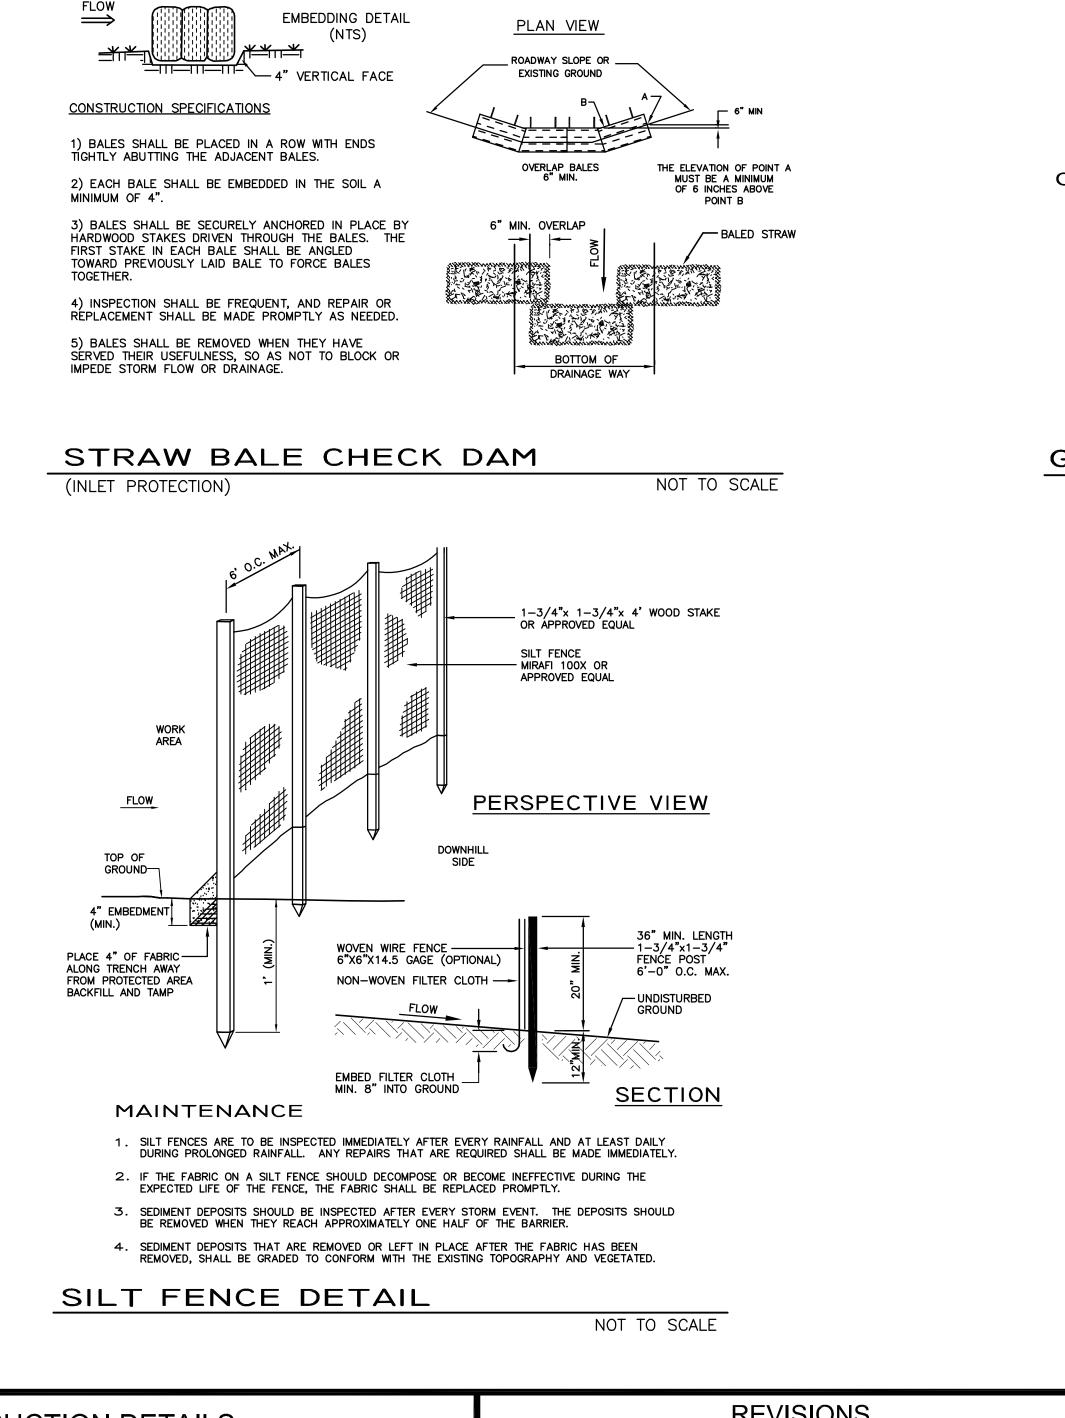

DATE

REVISIONS DESCRIPTION DWN BY CK BY 1/04/22 REV. PER NRPC STAFF COMMENTS (11/29/21)

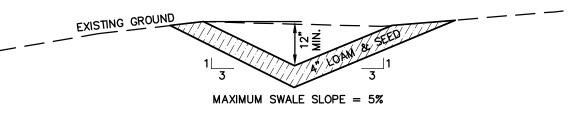

CONSTRUCTION NOTES

1. THE FOUNDATION AREA OF THE WATERWAY SHALL BE CLEARED AND GRUBBED OF ALL TREES, BRUSH, STUMPS AND OTHER OBJECTIONABLE MATERIAL. MATERIALS REMOVED SHALL BE DISPOSED OF SO THEY DO NOT INTERFERE WITH THE CONSTRUCTION OR PROPER FUNCTION OF THE WATERWAY.

2. THE WATERWAY SHALL BE EXCAVATED OR SHAPED TO LINE, GRADE, AND CROSS SECTION AS REQUIRED TO MEET THE DESIGN CRITERIA. THE WATERWAY SHALL BE FREE OF IRREGULARITIES WHICH WILL IMPEDE NORMAL FLOW. 3. EARTH FILLS REQUIRED TO MEET SUBGRADE REQUIREMENTS BECAUSE OF OVER EXCAVATION OR TOPOGRAPHY SHALL BE COMPACTED TO THE SAME DENSITY AS THE SURROUNDING SOIL TO PREVENT UNEQUAL SETTLEMENT THAT COULD CAUSE DAMAGE TO THE COMPLETED WATERWAY. EARTH REMOVED AND NOT NEEDED IN CONSTRUCTION SHALL BE SPREAD OR DISPOSED OF SO THAT IT WILL NOT INTERFERE WITH THE FUNCTIONING OF THE WATERWAY.

4. CONSTRUCTION OPERATIONS SHALL BE CARRIED OUT IN SUCH A MANNER AS TO MINIMIZE EROSION AND AIR AND WATER POLLUTION. ALL APPROPRIATE STATE AND LOCAL LAWS AND REGULATIONS SHALL BE COMPLIED WITH FOR DESIGN AND INSTALLATION.

5. THE WATERWAY SHALL BE STABILIZED USING THE APPROPRIATE "BEST MANAGEMENT PRACTICES" FOR VEGETATIVE MEASURES.

GRASS LINED SWALE

NOT TO SCALE



Rokeh Consulting, LLC 89 KING ROAD, CHICHESTER, NH

PH: 603-387-8688

SCALE: AS NOTED DATE: NOVEMBER 15, 2021 DR. BY: JR CK. BY: JR JOB NO. ____ SHEET NO. 3 OF 4

GENERAL NOTES:

1. PROJECT ENGINEER: ROKEH CONSULTING, LLC, 89 KING ROAD, CHICHESTER, NH 03258

2. ALL MATERIALS AND METHODS OF CONSTRUCTION SHALL CONFORM TO TOWN REGULATIONS AND THE LATEST EDITION OF NEW HAMPSHIRE DEPARTMENT OF TRANSPORTATION'S STANDARD SPECIFICATIONS FOR ROAD & BRIDGE CONSTRUCTION.

3. IF, DURING CONSTRUCTION IT BECOMES APPARENT THAT DEFICIENCIES EXIST IN THE APPROVED DESIGN DRAWINGS, THE CONTRACTOR, DEVELOPER OR OWNER ARE RESPONSIBLE TO DOCUMENT THE APPARENT DEFICIENCIES AND NOTIFY THE DESIGN ENGINEER PRIOR TO CONTINUING CONSTRUCTION ACTIVITIES. THE DESIGN ENGINEER, IN COOPERATION WITH THE CONTRACTOR, DEVELOPER OR OWNER WILL RESOLVE THE APPARENT DEFICIENCIES TO MEET APPLICABLE TOWN REGULATIONS.

4. IF, DURING CONSTRUCTION, IT BECOMES APPARENT THAT ADDITIONAL EROSION CONTROL MEASURES ARE REQUIRED, THE CONTRACTOR, DEVELOPER OR OWNER SHALL BE REQUIRED TO INSTALL ADDITIONAL EROSION PROTECTION MEASURES. 5. THE CONTRACTOR SHALL CONTACT ALL UTILITY COMPANIES PRIOR TO CONSTRUCTION TO VERIFY THE LOCATION OF ALL UTILITIES

OVERHEAD OR UNDERGROUND, WITHIN THE CONSTRUCTION AREA. THE PROTECTION OR RELOCATION OF UTILITIES IS ULTIMATELY THE RESPONSIBILITY OF THE CONTRACTOR. (DIG SAFE NUMBER PROVIDED ON SHEET 1)

6. THE CONTRACTOR SHALL MAINTAIN EMERGENCY ACCESS TO ALL AREAS AT ALL TIMES.

7. NO EXCAVATED AREA SHALL BE LEFT UNATTENDED AND SHALL BE THOROUGHLY SECURED ON A DAILY BASIS.

THE PROJECT IS TO BE MANAGED IN A MANNER THAT MEETS THE REQUIREMENT AND INTENT OF RSA 430:53 AND CHAPTER AGY 3800 RELATIVE TO INVASIVE SPECIES.

CONSTRUCTION SEQUENCE:

1. CUT AND CLEAR TREES WITHIN LIMIT OF WORK (PROPOSED TREELINE), UNLESS OTHERWISE NOTED. ALL STUMPS, BRANCHES, TOPS AND BRUSH TO BE PROPERLY DISPOSED OF, PREFERABLY OFF SITE.

2. CONSTRUCT STABILIZED CONSTRUCTION ENTRANCE AS SHOWN AND DETAILED IN THIS PLAN SET.

3. CONSTRUCT TEMPORARY AND PERMANENT EROSION CONTROL FACILITIES (DETENTION BASINS, TREATMENT SWALES, GRASS SWALES AND STONE LINED RIP-RAP SWALES) PRIOR TO ANY EARTH MOVING OPERATION. 4. ALL SWALES AND DITCH LINES SHALL BE PROTECTED FROM EROSION. ALL DITCHES AND SWALES SHALL BE STABILIZED PRIOR TO

DIRECTING RUNOFF TO THEM. 5. ALL STORM DRAINAGE SYSTEMS SUCH AS DETENTION/RETENTION BASINS, TREATMENT SWALES AND LEVEL SPREADERS SHALL BE PROTECTED FROM EROSION. ALL STORM DRAINAGE SYSTEMS SHALL BE STABILIZED PRIOR TO DIRECTING FLOW INTO THEM.

6. CONSTRUCT TEMPORARY CULVERTS, DIVERSION DITCHES/SWALES OR BERMS AS REQUIRED TO MINIMIZE THE EROSIVE AFFECTS OF STORMWATER RUNOFF DURING ALL CONSTRUCTION ACTIVITIES.

7. COMPLETE GRUBBING OPERATIONS. ALL STUMPS AND DEBRIS SHALL BE PROPERLY DISPOSED OF, PREFERABLY OFF SITE.

8. ALL MATERIAL SUITABLE FOR USE AS TOPSOIL SHALL BE STOCKPILED IN UPLAND AREAS. ALL STOCKPILES SHALL BE SEEDED WITH WINTER RYE AND IF NECESSARY, SURROUNDED WITH SILT FENCE, AND/OR STRAW BALES, IN ORDER TO PREVENT OR CONTAIN SOIL EROSION

9. ALL MATERIAL SUITABLE FOR FILL OR SELECT MATERIAL SHALL BE STOCKPILED IN UPLANDS AREAS. ALL STOCKPILES SHALL BE SURROUNDED WITH SILT FENCE, AND/OR STRAW BALES, IN ORDER TO CONTAIN SOIL EROSION.

10. COMPLETE ROADWAY SLOPE GRADING/EMBANKMENT CONSTRUCTION. ALL SLOPES SHALL BE STABILIZED AND SEEDED IMMEDIATELY AFTER GRADING. THE CONTRACTOR SHALL STABILIZE SLOPES WITH APPROPRIATE SEEDING PROGRAM OR JUTE MAT, WHEREVER SPECIFIED.

11. APPLY TOPSOIL TO PARKING LOT SLOPES AND OTHER AREAS DISTURBED BY CONSTRUCTION. TOPSOIL USED MAY BE NATIVE ORGANIC MATERIAL SCREENED AS TO BE FREE FROM ROOTS, BRANCHES, STONES, AND OTHER DELETERIOUS MATERIALS. TOPSOIL SHALL BE APPLIED SO AS TO PROVIDE A MINIMUM OF A 4-INCH COMPACTED THICKNESS. UPON COMPLETION OF TOPSOILING, FINISHED LIMED, SEEDED, AND MULCHED. THE CONTRACTOR SHALL INSPECT COMPLETED SECTIONS OF WORK ON A REGULAR BASIS AND REMEDY ANY PROBLEM AREAS UNTIL A HEALTHY STAND OF GRASS IS ESTABLISHED.

12. MAINTAIN, REPAIR, AND REPLACE TEMPORARY EROSION CONTROL MEASURES AS NECESSARY FOR A MINIMUM PERIOD OF 12 MONTHS FOLLOWING SUBSTANTIAL COMPLETION.

13. AFTER STABILIZATION (12 MONTHS FOLLOWING SUBSTANTIAL COMPLETION), REMOVE AND PROPERLY DISPOSE OF TEMPORARY EROSION CONTROL MEASURES, PREFERABLY OFF SITE.

WINTER CONSTRUCTION NOTES

a. ALL PROPOSED VEGETATED AREAS WHICH DO NOT EXHIBIT A MINIMUM OF 85% VEGETATIVE GROWTH BY OCTOBER 15TH, OR WHICH ARE DISTURBED AFTER OCTOBER 15TH, SHALL BE STABILIZED BY SEEDING AND INSTALLING EROSION CONTROL BLANKETS ON SLOPES GREATER THAN 3:1, AND SEEDING AND PLACING 3 TO 4 TONS OF MULCH PER ACRE, SECURED WITH ANCHORED NETTING, ELSEWHERE. THE INSTALLATION OF EROSION CONTROL BLANKETS OR MULCH AND NETTING SHALL NOT OCCUR OVER ACCUMULATED SNOW OR ON FROZEN GROUND AND SHALL BE COMPLETED IN ADVANCE OF THAW OR SPRING MELT EVENTS.

b. ALL DITCHES OR SWALES WHICH DO NOT EXHIBIT A MINIMUM OF 85% VEGETATIVE GROWTH BY OCTOBER 15TH, OR WHICH ARE DISTURBED AFTER OCTOBER 15TH, SHALL BE STABILIZED TEMPORARILY WITH STONE OR EROSION CONTROL BLANKETS APPROPRIATE FOR THE DESIGN FLOW CONDITIONS.

C. AFTER NOVEMBER 15TH, INCOMPLETE ROAD OR PARKING SURFACES, WHERE WORK HAS STOPPED FOR THE WINTER SEASON, SHALL BE PROTECTED WITH A MINIMUM OF 3 INCHES OF CRUSHED GRAVEL PER NHDOT ITEM 304.3.

Owner / Applicant: ISAAC FRYE HOLDINGS, LLC 586 Turnpike Road New Ipswich, NH 03071

SEEDING SPECIFICATIONS

	MIXTURE	POUNDS/ACRE	POUNDS/1.000 SF				
		AND DROUGHTY CONDITION					
	TALL FESCUE CREEPING RED FESCUE	20 20	0.45 0.45				
	REDTOP	2	<u>0.05</u>				
	TOTAL	42	0.95				
1. SEEDBED PREPARATION A. SURFACE AND SEEPAGE WATER SHOULD BE DRAINED OR DIVERTED FROM THE SITE TO PREVENT DROWNING OR WINTER KILLING OF THE PLANTS.							
В.	STONES LARGER THAN FOUR INCHES AND TRASH SHOULD BE REMOVED BECAUSE THEY INTERFERE WITH SEEDING AND FUTURE MAINTENANCE OF THE AREA. WHERE FEASIBLE, THE SOIL SHOULD BE TILLED TO A DEPTH OF ABOUT FOUR INCHES TO PREPARE A SEEDBED AND MIX FERTILIZER AND LIME INTO THE SOIL. THE SEEDBED SHOULD BE LEFT IN A REASONABLY FIRM AND SMOOTH CONDITION. THE LAST TILLAGE OPERATION SHOULD BE PERFORMED ACROSS THE SLOPE WHEREVER PRACTICAL.						
	SOIL. KINDS AND AMOUNT	S OF LIME AND FERTILIZER S⊢	AT THE TIME OF SEEDING AND INC IOULD BE BASED ON EVALUATION (1 AMOUNTS SHOULD BE APPLIED:				
	 AGRICULTURAL LIMESTONE: 2 TONS PER ACRE OR 0.09 LBS. PER SQ. FT. NITROGEN (N): 50 LBS. PER ACRE OR 1.1 LBS. PER 1000 SQ. FT. PHOSPHATE (P₂O₅): 100 LBS. PER ACRE OR 2.2 LBS. PER 1000 SQ. FT. POTASH (K₂O): 100 LBS. PER ACRE OR 2.2 LBS. PER 1000 SQ. FT. (NOTE: THIS IS THE EQUIVALENT OF 500 LBS. PER ACRE OF 10-20-20 FERTILIZER OR 1,000 LBS. PER ACRE OF 5-10-10) 						
В.		AND HYDROSEEDING. WHERE E	IOST APPROPRIATE FOR THE SITE. BROADCASTING IS USED, COVER SE				
C.	DEVELOPING AREAS IN NEW	/ HAMPSHIRE", FOR APPROPRIA	AND SEDIMENTATION CONTROL HAN ATE SEED MIXTURES AND TABLE 7- OIL, AND FLATPEA), MUST BE INOC	-36 FOR RATES OF			
D.			MADE FROM EARLY SPRING TO EABLE MADE FROM EARLY SPRING TO				
3. MULC A.		MULCH, WHEN NEEDED, SHOU	LD BE APPLIED IMMEDIATELY AFTER	SEEDING.			
В.	MULCH WILL BE HELD IN PL AS SHOWN IN, "STORMWATE DEVELOPING AREAS IN NEW	ER MANAGEMENT AND SEDIMEN	I THE "BEST MANAGEMENT PRACTION CONTROL HANDBOOK FOR	CE FORMULCHING", URBAN AND			
	TENANCE TO ESTABLISH A S PLANTED AREAS SHOULD B		BY FIRE, GRAZING, TRAFFIC, AND [DENSE WEED GROWTH.			
В.			E INSPECTIONS. SUPPLEMENTAL FE TAND BECAUSE MOST PERENNIALS				

C. IN WATERWAYS, CHANNELS, OR SWALES WHERE UNIFORM FLOW CONDITIONS ARE ANTICIPATED, OCCASIONAL MOWING MAY BE NECESSARY TO CONTROL GROWTH OF WOODY VEGETATION.

ALL RECLAMATION ACTIVITIES SHALL BE IN ACCORDANCE WITH NRCS'S TECHNICAL NOTE PM-NH-21 "VEGETATING NEW HAMPSHIRE SAND AND GRAVEL PITS".

EROSION CONTROL NOTES

ALL EROSION CONTROL MEASURES SHALL BE INSTALLED AND MAINTAINED FOR THE DURATION OF THE PROJECT IN ACCORDANCE WITH FEDERAL, STATE AND LOCAL REGULATIONS (EPA, NHDES AND TOWN REGULATIONS). THE GENERAL NOTES AND DETAILS CONTAINED IN THIS PLAN SERVE AS A GUIDE ONLY.

1. PERIMETER CONTROLS SHALL BE INSTALLED PRIOR TO EARTH MOVING OPERATIONS. INSTALLATION OF STRAWBALE BARRIERS AND "FILTREXX SOXX" OR SILTATION FENCES SHALL BE COMPLETED PRIOR TO THE START OF SITE WORK IN ANY SPECIFIC AREA. PREFABRICATED SILTATION FENCES AND "FILTREXX SOXX" SHALL BE INSTALLED ACCORDING TO THE MANUFACTURER'S RECOMMENDATIONS.

2. STRAWBALE BARRIERS AND SILTATION FENCES SHALL BE KEPT CLEAN DURING CONSTRUCTION AND REMOVED WHEN ALL SLOPES HAVE A HEALTHY STAND OF VEGETATIVE COVER. EROSION CONTROL MEASURES SHALL BE INSPECTED ON A WEEKLY BASIS AND WITHIN 24 HOURS AFTER A RAINFALL EVENT GREATER THAN 0.5 INCHES

4. THE SMALLEST PRACTICAL AREA SHALL BE DISTURBED DURING CONSTRUCTION, BUT IN NO CASE SHALL EXCEED 5 ACRES AT ANY ONE TIME BEFORE DISTURBED AREAS ARE STABILIZED. ALL ROADWAYS AND/OR PARKING LOTS SHALL BE STABILIZED WITHIN 72 HOURS OF ACHIEVING FINISH GRADE. CUT AND FILL SLOPES SHALL BE LOAMED & SEEDED WITHIN 72 HOURS OF ACHIEVING FINISH GRADE. TEMPORARY AND/OR PERMANENT STABILIZATION SHALL BE INSTALLED WITHIN 60 DAYS OF INITIAL CONSTRUCTION.

AN AREA SHALL BE CONSIDERED STABLE IF ONE OF THE FOLLOWING HAS OCCURED: a. BASE COURSE GRAVELS HAVE BEEN INSTALLED IN AREAS TO BE PAVED b. A MINIMUM OF 85% VEGETATED GROWTH HAS BEEN ESTABLISHED C. A MINIMUM OF 3 INCHES OF NON-EROSIVE MATERIAL SUCH AS STONE OR RIP-RAP HAS BEEN INSTALLED d. OR, EROSION CONTROL BLANKETS HAVE BEEN PROPERLY INSTALLED TIME LIMIT: ALL AREAS SHALL BE STABILIZED WITHIN 45 DAYS OF INITIAL DISTURBANCE.

5. ALL DISTURBED AREAS SHALL HAVE A MINIMUM OF 4" OF LOAM INSTALLED WITH NOT LESS THAN 1.1 POUNDS OF SEED MIX PER 1,000 SQ. FT. SEE SEEDING SPECIFICATIONS ON THIS SHEET

6. LIME AND FERTILIZER SHALL BE INCORPORATED INTO THE SOIL PRIOR TO OR AT THE TIME OF AT THE TIME OF SEEDING. A MINIMUM OF 2 TONS PER ACRE OF AGRICULTURAL LIMESTONE AND 500 LBS. PER ACRE OF 10-20-20 FERTILIZER SHALL BE APPLIED. SEEDING PRACTICES SHALL COMPLY WITH LOCAL USDA SOIL CONSERVATION SERVICES RECOMMENDATIONS.

7. STRAW MULCH OR JUTE MATTING SHALL BE USED IF/WHERE INDICATED ON THE PLANS. A MINIMUM OF 1.5 TONS OF MULCH PER ACRE SHALL BE APPLIED. MULCH SHALL BE ANCHORED IN PLACE WHERE NECESSARY. JUTE MATTING SHALL BE LAID IN THE DIRECTION OF RUNOFF FLOW FLOW AND APPLIED IN ACCORDANCE WITH MANUFACTURER'S INSTRUCTIONS.

8. PERMANENT OR TEMPORARY COVER MUST BE IN PLACE BEFORE THE GROWING SEASON ENDS. WHEN SEEDED AREAS ARE MULCHED, PLANTINGS MAY BE MADE FROM EARLY SPRING TO EARLY OCTOBER. WHEN SEEDED AREAS AREA NOT MULCHED, PLANTINGS SHOULD BE MADE FROM EARLY SPRING TO MAY 20 OR FROM AUGUST 15 TO SEPTEMBER 15. NO DISTURBED AREA SHALL BE LEFT EXPOSED DURING WINTER MONTHS.

CONSTRUCTION DETAILS	REVISIONS			
"Proposed Residence"	DATE	DESCRIPTION	DWN BY	CK BY
TAX LOT F-3-2	1/04/22	REV. PER NRPC STAFF COMMENTS (11/29/21)	JR	JR
Isaac Frye Highway				
Wilton, New Hampshire				

3. EXISTING VEGETATION IS TO REMAIN UNDISTURBED WHEREVER POSSIBLE.



Rokeh Consulting, LLC 89 KING ROAD, CHICHESTER, NH

PH: 603-387-8688

SCALE: AS NOTED DATE: NOVEMBER 15, 2021 DR. BY: JR CK. BY: JR JOB NO. ____ SHEET NO. 4 OF 4